

TRANSNET PROPERTY

TENDER NUMBER: TP/2023/06/0005/33418/RFP-CIDB

DESCRIPTION OF THE WORKS:PROVISION OF THE SERVICES FOR THE RESURFACING OF ROADWAYS, UNDERGROUND SERVICES UPGRADE, PROVISION OF ACCESS CONTROL, SALT RIVER, CAPE TOWN FOR A PERIOD OF TWELVE (12) MONTHS

PART 4: SITE INFORMATION

Core clause 11.2(16) states

"Site Information is information which

- describes the Site and its surroundings and
- is in the documents which the Contract Data states it is in."

In Contract Data, reference has been made to this Part 4 of the contract for the location of Site Information.

The Contractor shall attend the site clarification meeting and acquaint himself with the nature of the works, the conditions under which the work is to be performed, and the means of access to the affected properties. Any limitations or other authorities and in general with all matters that may influence that may affect the contract.

1. Description of the Site and its surroundings

1.1. General description

The site is located in Salt River, Cape Town as indicated shown in figure 1 below. Multiple tenants occupy the site and the roads are frequented by various type of vehicles but by mainly heavy duty container trucks, horse and trailers and heavy duty wood logs trucks.

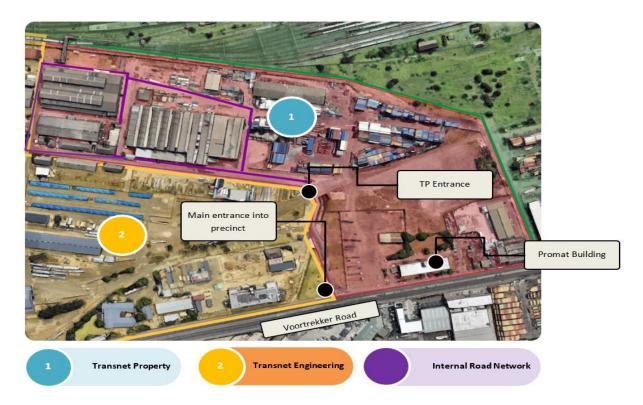


Fig. 1 Salt River Precinct site layout



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A portion of the site's stormwater network has become dysfunctional and is causing continuous flooding in front of one of the Warehouses. The double storey office block, Promat Building's parking lot and adjacent unpaved yards have no adequate storm water network.



Fig 2. Road and existing paving conditions



Fig 3. Roads and existing access control



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Fig 4. Promat Building burnt room, damp walls and roof slab

1.2. Existing buildings, structures, and plant & machinery on the Site

The drawing layout plans provided shows the different existing buildings and structures. There are reach stackers and forklifts that the tenants own and operate on the site which the contractor will need to be aware of and plan the construction program around the tenant's operations to effect little or no interruptions.

1.3. Hidden services

The contractor is to provide cable detection services before excavation next to highlighted electrical cables as shown on the provided drawings. All uncovered electrical cables must be treated as live until they are certified dead by a professional electrician.





ISNEED-W

A 646/13 ISSUED FOR CONSTRUCTION
1 646/13 ISSUED FOR CONSTRUCTION

TITLE
FLOOR SLAB LAYOUT, SECTIONS AND DETAILS

108-186801

MEA

AVERES SIZE

186801


PROJECT NO.


FOR CONSTRUCTION


PROJECT TRANSNET: PROMAT BUILDING


G. FREDERICKS

O NOILOS

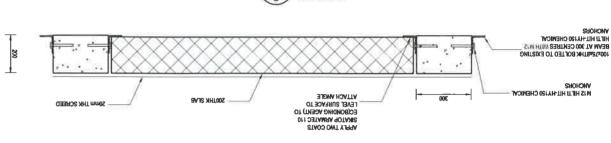

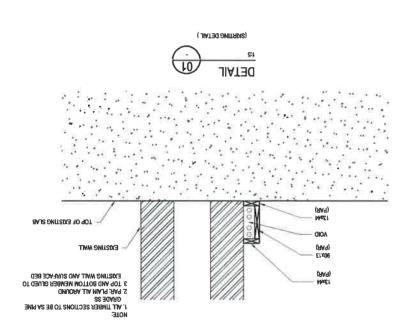

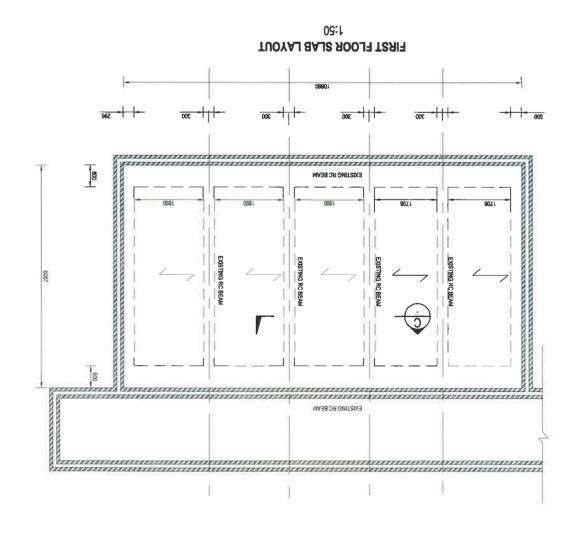

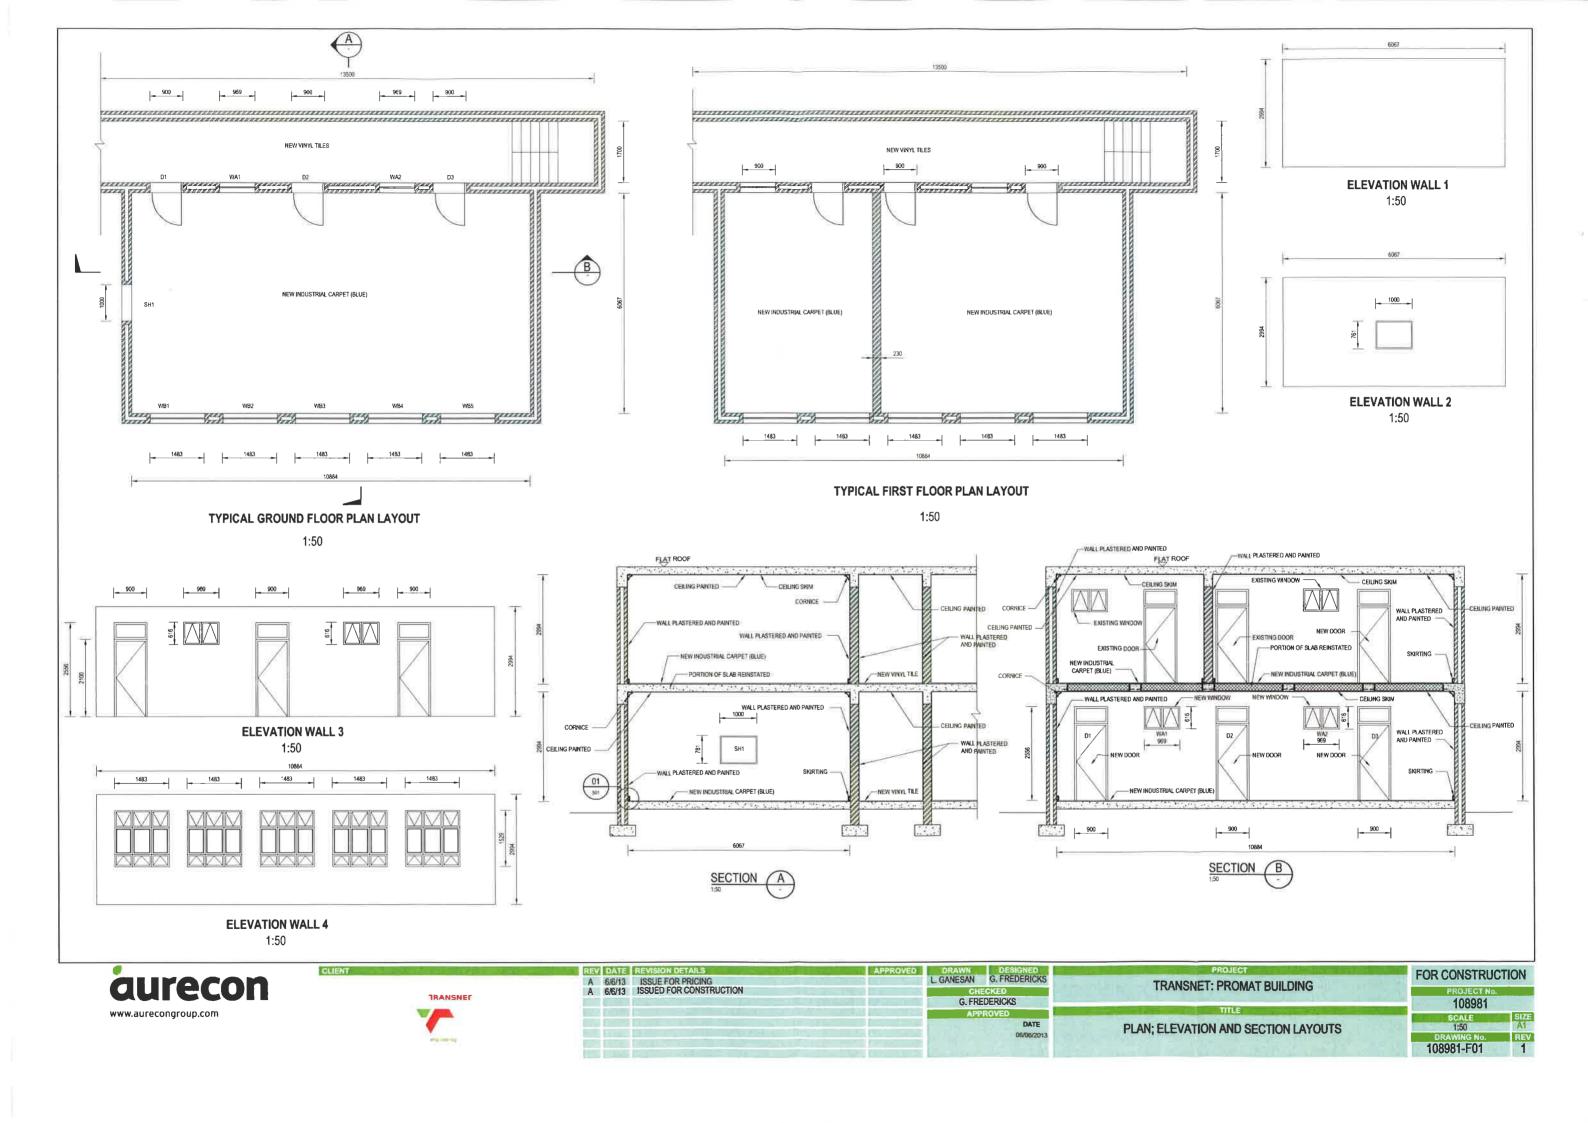

	900 NAMO. 957 2.100 900 900 900 900	
ТҮРЕ	D	
TYPE DESCRIPTION	Solid Hardwood Doors	
DOOR	Swartland or similar 136 approved, 44mm thick PD1 framed,ledged and battened open back hardwood door.alze 813x 2032mm high(code:PD1), sealed with linseed oil besed transit stabilizing sealer. Sand down thome surface to a fine finish and apply three costs Swartland Maxicare quality timber sealent prior to installation, all in accordance with manufacturer's recommendations, all in accordance with manufacturer's recommendations, all in accordance with Maxicare quality timber sealers prior to installation, all in accordance with Aurecon drawing 104474/MAPL BIZZE	
FRAME	70x70mm Hantwood single rebated door frame. Frame to be built into walls with standard frame enchors or lugs Frame to be painted same ook or as door	
FIRE RATING		
IRONMONGERY HANDLES	UNION aluminium Sable handles on 150x150 Oval backplate AL6SA20-13AS, escutcheons included with anodized silver finish. PWO Reference - SN-132(a)	1
LOCKS	UNION Oval Double Cyfinder 2X68C, UNION Oval Cyclinder Upright lock case. Commercial Quality - L-2241-78es. SABS approved. Dpw Hardware Semple List, Ref No SN - 6	
HINGES	1,5 Pair of 100mm Aluminium Butt Hinges to door leaf	
CLOSER	777 Regular Arm overhead door closer as per UNION - Size En 2-4	
OTHER	AL6730AS Aluminium door stop as per UNION	

WINDOW SCHEDULE	NB - ALL DIMENSIONS TO BE VERIFIED ON SITE AND SPECIALIST SHOP DRAWINGS TO BE SUBMITTED FOR APPROVAL TO ARCHITECT PRIOR TO MANUFACTURE NOTE - ALL SECTIONS SIZES SHOWN ARE PROVISIONAL & SUBJECT TO FINAL RECOMMENDATION	
	969	1453 402 439 402 FORED FORED FARED
TYPE	WA	WB
WINDOW NUMBERS	WA1 TO WA2	WB1 TO WBS
NUMBER REQUIRED	2	5
DESCRIPTION	OPENING SECTION: PURPOSE MADE ALUMINIUM. SECTION AS PER MANUFACTURERS SPECIFICATION. FRAME: ALUMINIUM FRAME AS PER MANUFACTURERS SPECIFICATION	OPENING SECTION: PURPOSE MADE ALUMINIUM SECTION AS PER MANUFACTURERS SPECIFICATION. FRAME: ALUMINIUM FRAME AS PER MANUFACTURERS SPECIFICATION
FINISH	POWDER COATED, COLOUR PLASCON EXPRESSIONS E-29-6 BOVINE	POWDER COATED, COLOUR PLASCON EXPRESSIONS E-29-6 BOVINE
IRONMONGERY	AS PER MANUFACTERERS SPECIFICATION TO CLIENTS APPROVAL	AS PER MANUFACTERERS SPECIFICATION TO CLIENTS APPROVAL
GLAZING	INTRUDER PROOF, CLEAR FLOAT, SAFETY GLASS, ALL GLAZING TO COMPLY WITH NATIONAL BUILDING REGULATIONS SANS 10400	INTRUDER PROOF, CLEAR FLOAT, SAFETY GLASS. ALL GLAZING TO COMPLY WITH NATIONAL BUILDING REGULATIONS SANS 10400
VENTILATION	AS INDICATED	AS INDICATED
WINDOW SEALING	NOISE AND DUST SEALERS TO BE SUPPLIED AND INSTALLED	NOISE AND DUST SEALERS TO BE SUPPLIED AND INSTALLED


BURGLAR BAR SCHEDULE	NB - ALL DIMENSIONS TO BE VERIFIED ON SITE AND SPECIALIST SHOP DRAWINGS TO BE SUBMITTED FOR APPROVAL TO ARCHITECT PRIOR TO MANUFACTURE NOTE - ALL SECTIONS SIZES SHOWN ARE PROVISIONAL & SUBJECT TO FINAL RECOMMENDATION
	1483 INSIDE 395 394 150 OUTSIDE
	Burglar bars made up from 8x8mm galv, ms hortzontal steel bars welded to 8x16mm gal ms vertical steel bars, welded to 40x4mm
	steel fluing plate, boiled to well with BURGLAR BARS MADE UP FROM 8x8mm GALV. MS 10mm Ø rawl bolts HORIZONTAL STEEL BARS WELDED TO 8x16mm GALV, MS VERTICAL STEEL BARS.
TYPE	В
NUMBER REQUIRED	1
DESCRIPTION	BURGLAR BARS MADE UP FROM 8X8MIN GALV. MS HORIZONTAL STEEL BARS WELDED TO 8X16MM GALV. MS VERTICAL STEEL BARS. 8X16MM GALV. MS VERTICAL STEEL BARS, WELDED TO 40X24MIN STEEL FIXING PLATE, BOLTED TO WALL WITH 10MM Ø RAWL BOLTS
FINISH	GALV. MS BARS TO BE TREATED PRIOR TO FINAL COAT AS PER PLASCON SPECIFICATION OR EQUAL AND APPROVED - COLOR PLASCON EXPRESSIONS E-296 BOVINE






CLIENT

REV DATE	REVISION DETAILS
6/6/13	ISSUE FOR PRICING
6/6/13	ISSUE FOR CONSTRUCTION
1000	
THE RESERVE	
NAME OF STREET	

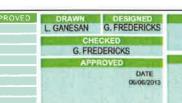


PROJECT- THE RESERVE OF THE PROJECT	ě
TRANSNET: PROMAT BUILDING	i
TITLE IN COLUMN TO THE COLUMN	ļ
DOOR; WINDOW AND BURGLAR BAR SCHEDULE	ŀ

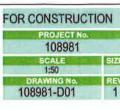



SECTION 4:

ELECTRICAL DESIGN DRAWINGS AND SPECIFICATIONS

DRAWING TITLE	DRAWING No.
GROUND & FIRST FLOOR LIGHTING AND POWER LAYOUT	108981-E01 REV1
SINGLE LINE DIAGRAM DB-1,DB-2	108981-E02 REV1
SMALL POWER AND LIGHTING	DETAIL SHEET NO 1
LUMINAIRE SCHEDULE	DETAIL SHEET NO 2

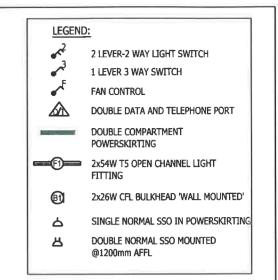


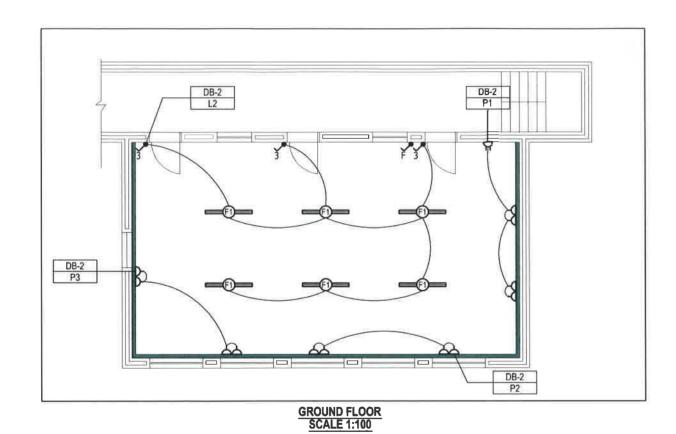


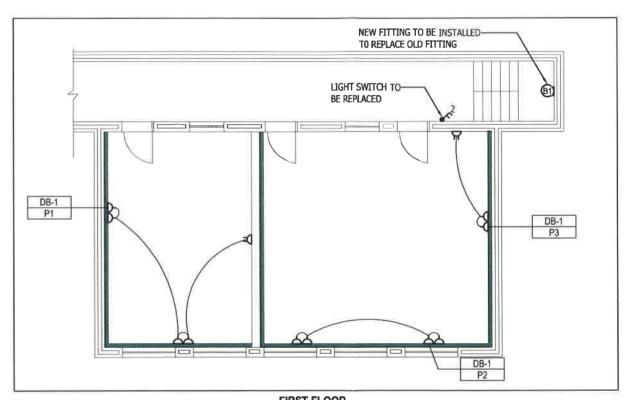


FIRST FLOOR SCALE 1:100



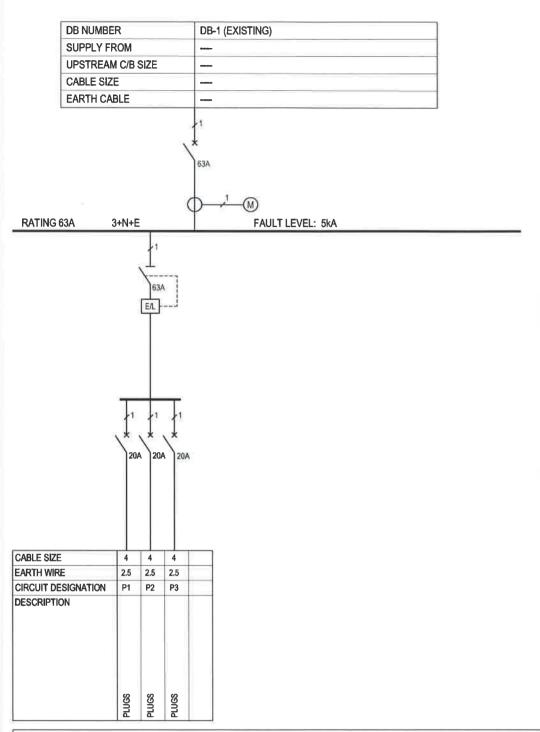

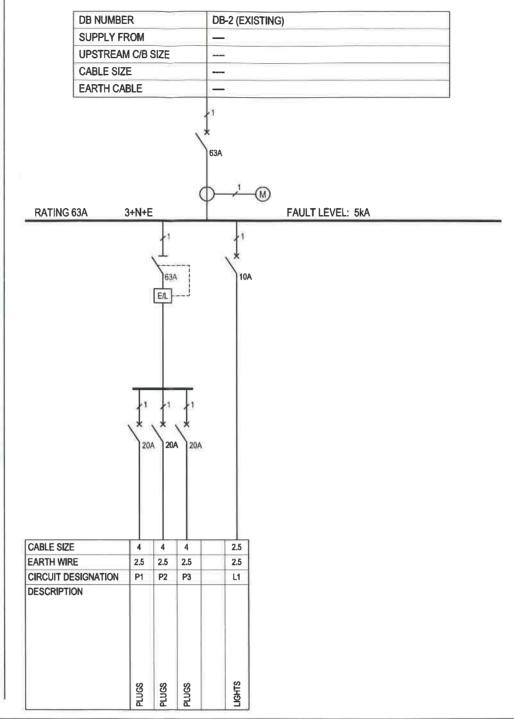


METHOD OF INSTALL	ATION	ACCESS REQUIREMENT	S	CONSTRUCTION DATA	COMPARTMENTS	CABLE ENTRY		FINAL FINISH		ELECTRICAL DATA	4	SPARE SPACE		PREFERRED EQU	JIPMEN
FLOOR STANDING		OPEN CONSTRUCTION	МІ	LD STEEL 1,6mm	INCOMER SECTION	TOP	•	EPOXY POWDER COATED	*	MAIN BUSBAR RATING		3 POLE	8	AIR CIRCUIT BREAKER	
WALL MOUNTED	•	DOORS	МІ	LD STEEL 2,0mm	NORMAL SECTION	воттом		DB COLOUR	WHITE	VOLTAGE RATING	230V	3 POLE MCB	**	CIRCUIT BREAKERS	
FLUSH		LOCKABLE DOORS	EL	ECTRO GALVANIZED	EMERGENCY SECTION	REAR		NORMAL SECTION	*	SUB BUSBAR FAULT LEVEL	•	1 POLE MCB	*	SURGE ARRESTERS	
PEDESTAL MOUNTED		FRONT ACCESS	ST	TAINLESS STEEL	UPS SECTION	SIDE		EMERGENCY SECTION	8	CONTROL VOLTAGE	230V	TABULAR COMPONENTS	-	CONTACTORS	
KIOSK		REAR ACCESS	3C	CR12	TABULAR CONSTRUCTION	NEUTRAL / EARTH		UPS SECTION	*	FREQUENCY	50Hz			CONTROL RELAYS	
ARCHITRAVE		REMOVABLE GLAND PLATES	FIE	BRE GLASS	METERING / INDICATION	FULL NEUTRAL				SURGE ARRESTOR RATING				TERMINALS	
OVER TRENCH		DOOR INTERLOCK	IPE	65	CONTROL TRANSFORMER	HALF NEUTRAL				POWER FACTOR CORRECTION	*			INDICATING LAMPS	
SURFACE						EARTH BAR								INSTRUMENTS	
						EARTH STUD								PFC CONTROLLER	
						INSULATED EARTH									

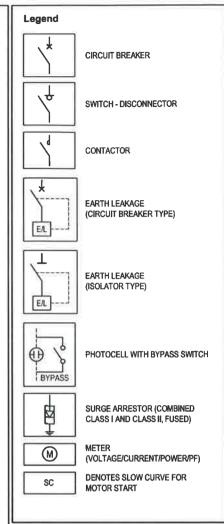





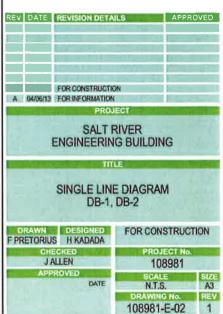

DETAIL SHEET NO 1


SMALL POWER AND LIGHTING

	DESCRIPTION	UNIT	SPECIFIED	OFFERED
NA.	LOW VOLTAGE COMPONENTS AND EQUIPMENT			
	PASSESSAD FILE POR SERVICE SER			
1	POWER OUTLETS			
-	POWER OUTLETS			
10	Industrial Switched Socket Outlets			17
1.2	Manufacturer	Transport Control		8
2.2	Type	HIGH HAVE		
2.3	Faceplate Colour	March 19 and 19	White	
1-2.0	acquite dolosi	Flush/recess		
1.2.5	Mounting	ed in power skirting	Various	
2	MINIATURE CIRCUIT BREAKERS			
			ADD similar and assessed	
2,1	Manufacturer	SIET INTO	ABB or similar and approved	
2.2	Type			
2.3	Model	4	Various	
2.4	Overcurrent Rating	A	various 5	
2.5	Fault Level Rating	kA		
2.6	Tripping Curve		-	
3	TELEPHONE AND DATA OUTLETS			
			The standard shall be	Data eshion and outlete shall be
		ES /Strate	Data cables and outlets shall be	Data cables and outlets shall be supplied and installed by others
3.1	Note	OR SALES	supplied and installed by others	supplied and installed by others
4	LIGHT SWITCHES			
4.1	1-Lever, 3-way light switch, Flush mounted Manufacturer	W. C. S. S.		
4.1.1		A		
4.1.2	Туре			
4.2	2-Lever, 2-way light switch, Flush mounted			
4.2.1	Manufacturer	No. of Street, or		
4.2.2	Type	THE RESERVE		
5	CEILING FAN			
5.1	Manufacturer		Eurolux or similar and approved	
5.2	Туре	MANAGER		
5.3	No. of blades	No.	3	
6	WIREMESH CABLE TRAY			
6.1	Manufacturer	FAIRU	CABSTRUT or similar and approved	
6.2	Range	140 151		
7	TRUNKING			
7.1	Manufacturer	TOWNSHIVE		
7.1		THE PERSON		
1.2	Range			
8	POWERSKIRTING			
8.1	Manufacturer	PERSONAL PROPERTY.	CABSTRUT or similar and approved	
8.2	Range	IX-U-C-C-		
9	SUPPLEMENTARY DETAILS			

Signature	Date	
Signature	- WIT	

	ETAIL SHEET NO 2 UMINAIRE SCHEDULE										
	LUMINAIRE / DEVICE TYPE:	DESCRIPTION	SUPPLIER / MANUFACTURER OR SIMILAR AND APPROVED:	PRODUCT NAME / CODE OR SIMILAR AND APPROVED:	LOCATION	LAMP TYPE:	BALLAST TYPE:	PLUG / LEAI TYPE:			
	DESIGNATION OF THE PERSON OF T	LUMINAIRE SCHEDULE	Well Control of the C	TANKS III.	THE SHAPE OF		į	I			
1		LIGHTING									
1.1		Wall Mounted indoor Bulkhead C/W 2X26W CFL Lamp and mounting	PROVINCE LIGHTING	PBH9-226	Stairwell	26W CFL	High Frequency Electronic	N/A - Hard wired			
1.2	F1	Ceiling Mounted Luminaire C/W 2 x54W T5 lamp	PROVINCE LIGHTING	POC1-254	Office	28W T5 HE	High Frequency Electronic	N/A - Hard wired			

Signature Date_____

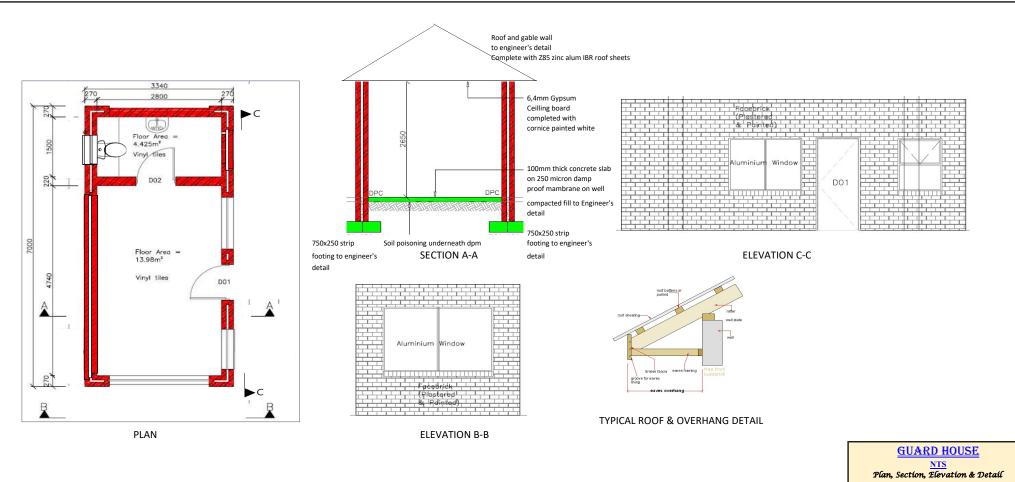

SK 01

